


THE SPRINGS AT RED MOUNTAIN Power Road & McDowell Rd. in Mesa Arizona 85215

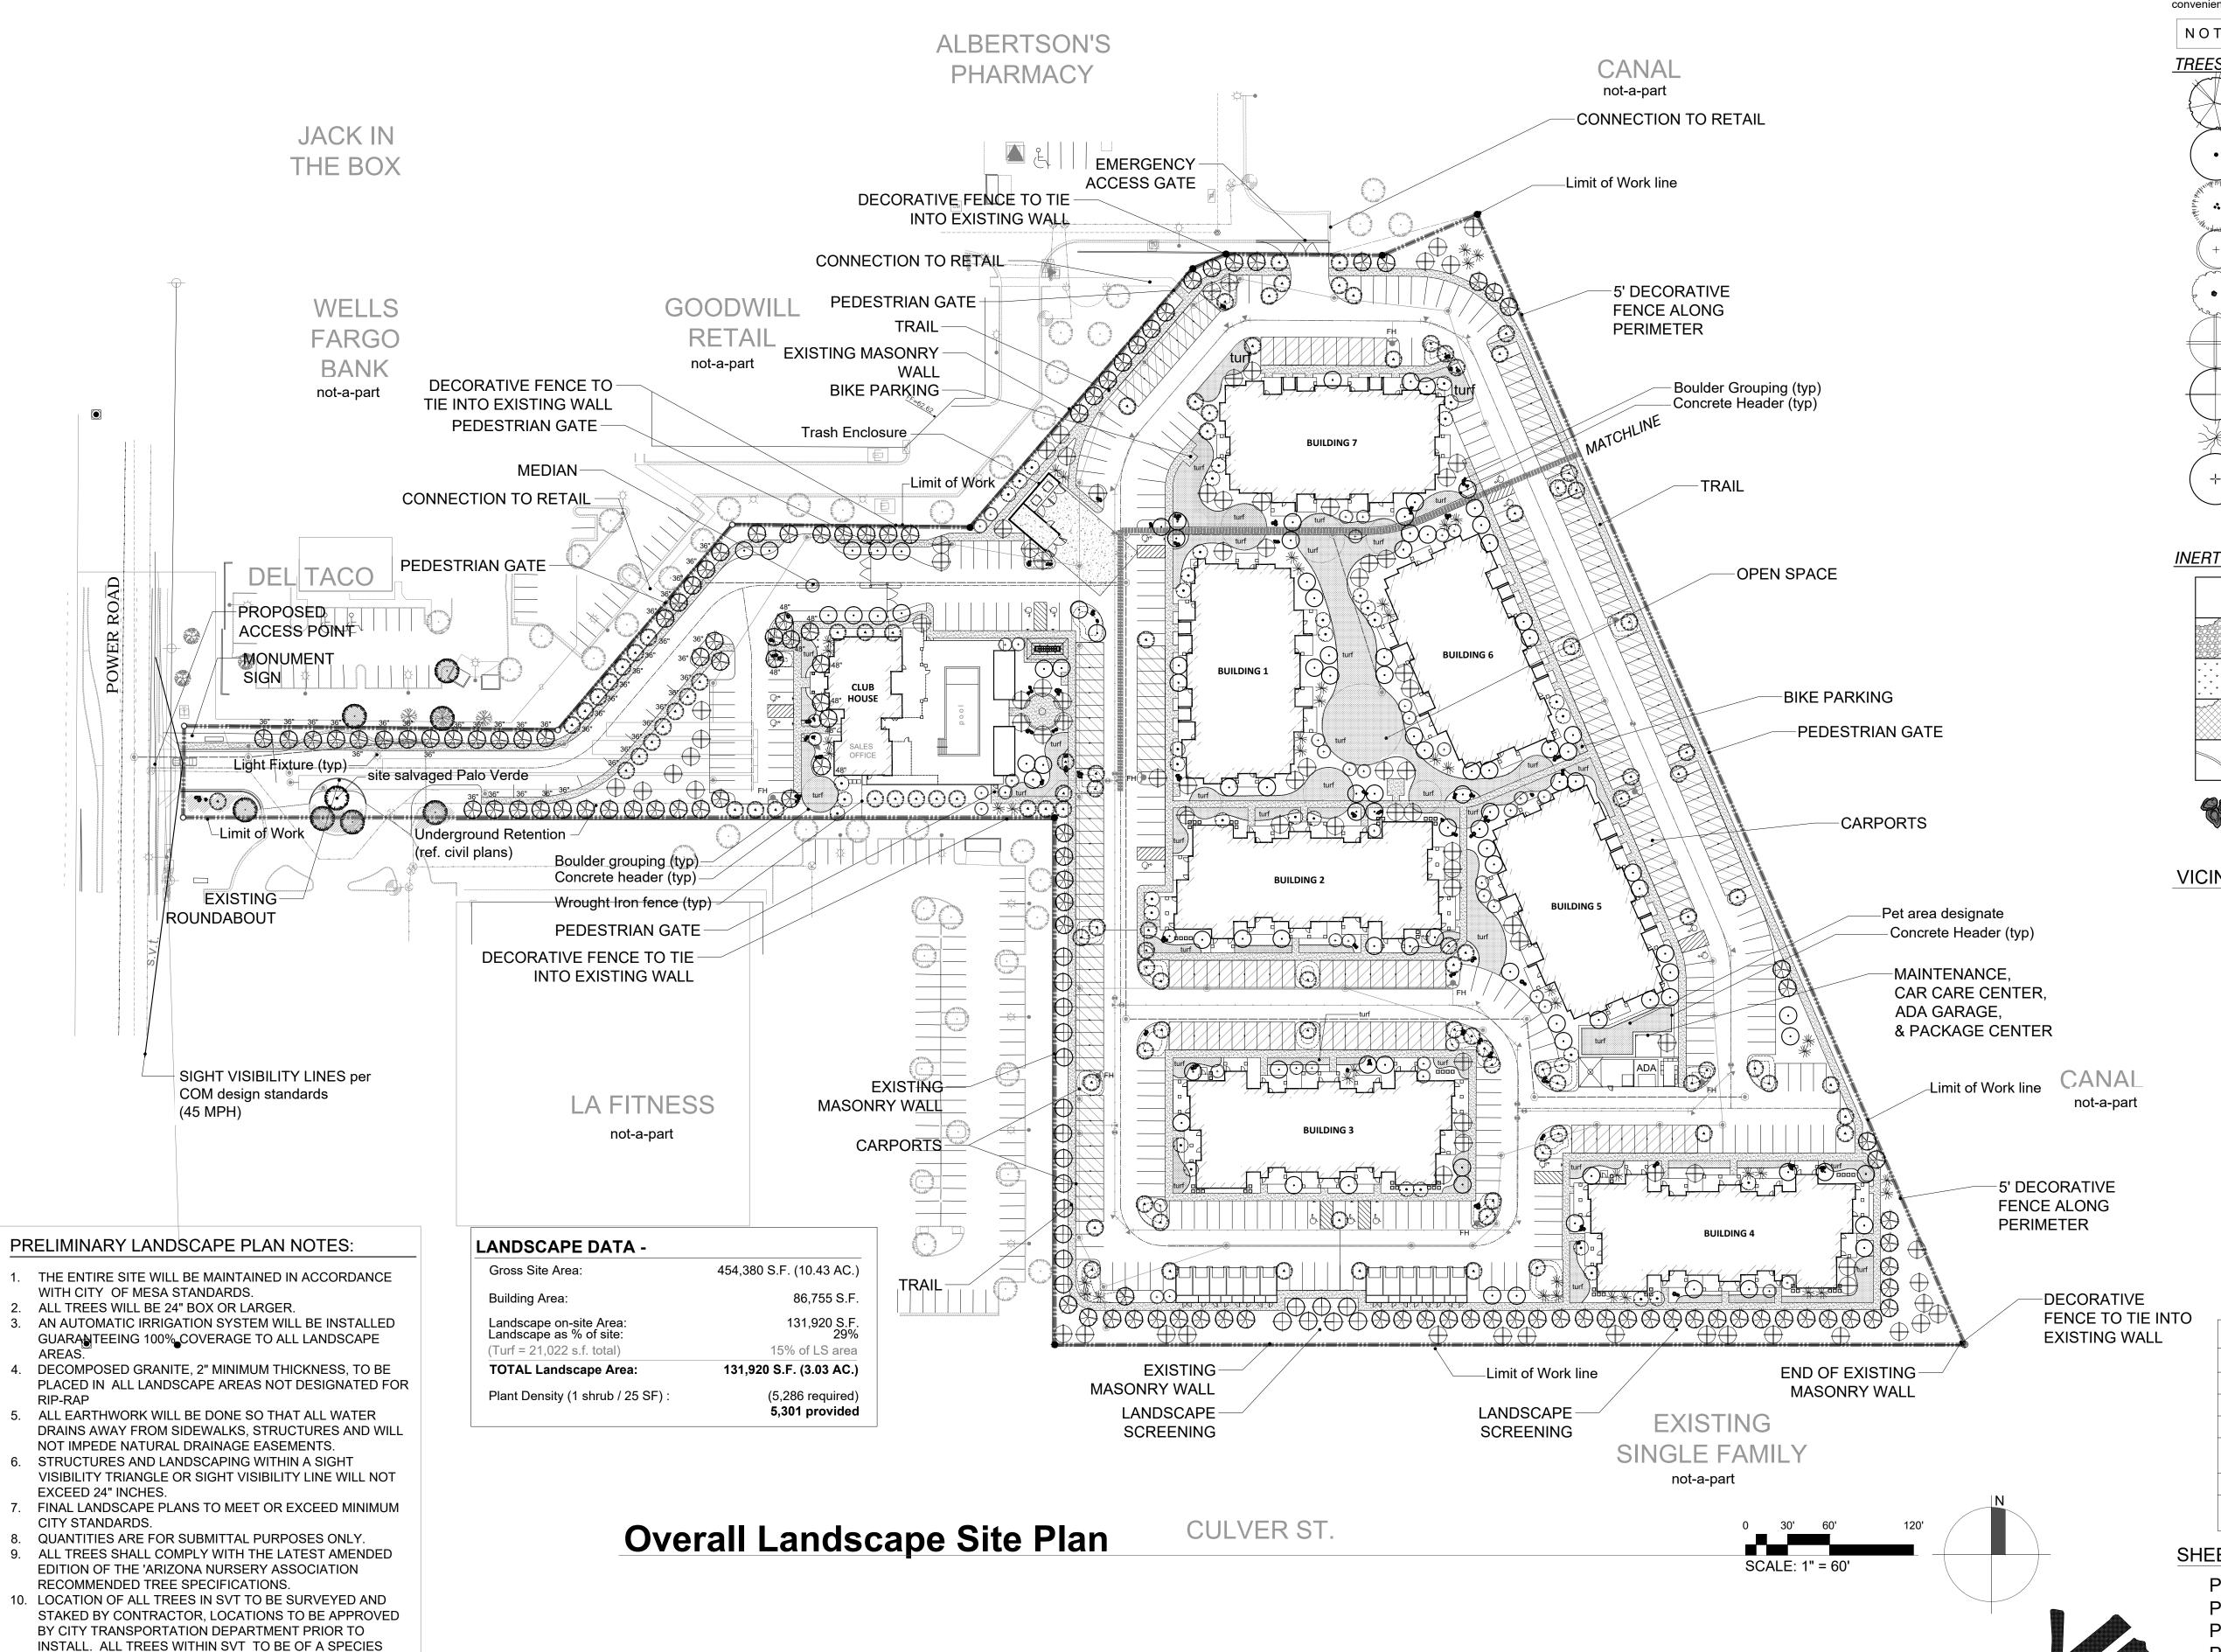

THAT WHEN FULLY MATURE WILL HAVE A TRUNK DIAMETER

11. AT TIME OF COMPLETION, ALL TREES IN SVT. TO BE PRUNE

TO 8' MEASURED FROM TOP OF CURB TO BOTTOM OF CANOPY, AND 14' HT. AS MEASURED FROM HIGHEST

12. ALL TREES LOCATED WITHIN SVT TO BE 36" BOX +

OF UNDER 12".

STANDARD TRUNK.

POINT OF ADJACENT PAVEMENT.

LANDSCAPE LEGEND ALL TREES TO MEET OR EXCEED A.N.A. SPECIFICATIONS During bid it shall be the responsibility of the Contractor to determine required quantities of plants, as no compensation will be made for error in plant quantities. If plant counts occur on plant legend, it is for the convenience of the contractor only. Verify plant counts with plan. in case of discrepancy, plan shall govern.

NOTE: Quantities, Shrubs, Accent and Ground Cover are found on sheet PL-02

TREES		
	Prosopis glandulosa (var. torreyana) Honey Mesquite	24" box UON, matching 36" box matching 48" box matching
•	Parkinsonia hybrid `Desert Museum` Desert Museum Palo Verde	36" box standard low breaking
The second of th	Parkinsonia florida Blue Palo Verde	24" box UON, multi 36" box multi
+	Sophora secundiflora Texas Mountain Laurel	36" box
	Ebenopsis ebano Texas Ebony	36" box, matching
	Prosopis x Phoenix® (Thornless) Thornless grafted Mesquite	24" box stand.
	Chilopsis Linearis Desert Willow	24" box, matching
X	Fouquieria splendens Ocotillo	8' - 8 cane min.

selectively trim to 7'

INERT MATERIAL

(SHRUBS FOUND ON SUBSEQUENT SHEETS AT 30 SCALE)


Mulch - DESERT COBBLE (3" minus, by Custom Landscape Materials)

Existing Tree to remain and be protected

	2" min thickness in all L.S. areas						
* * *	Fractured Granite rip-rap (4" to 6") install at down-spouts, roof drains & drainage outlets						
* * * * * * * * * * * * * * * * * * *	Turf : Mid-Iron sod, hybrid bermuda						
	Annuals	4" pot 8" o.c.					

4" x 6" Concrete Header at all turf and annual locations

Surface Select Granite Boulders 3'x3'x3' minimum size (boulders to be minimum 1 ton in weight) bury a min. 1/3

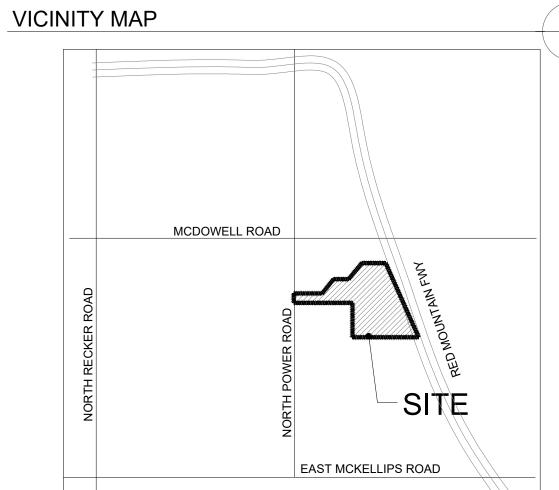

SITE DATA TABLE					
SITE AREA (AC)	±10.43				
SURFACE PARKING SPACES	204				
CARPORT SPACES	190				
ADA SURFACE SPACES	13				
ADA DETACHED GARAGE SPACES	1				
DETACHED GARAGE SPACES	12				
TOTAL PARKING SPACES PROVIDED	407				

SHEET INDEX

67 East Weldon Ave

f (602) 840-8021

www.laskindesign.com

PL-01 **OVERALL LANDSCAPE PLAN** PL-02 PRELIMINARY LS PLAN - NORTH PL-03 PRELIMINARY LS PLAN - SOUTH NATIVE PLANT PRESERVATION PLAN

LASKIN & ASSOCIATES, INC. LANDSCAPE ARCHITECTS

BEFORE YOU DIG 602-263-1100 1-800-STAKE-IT OUTSIDE MARICOPA COUNTY)

PROJ. ASSOC.: DRAWN BY: DATE: SCALE:


MOUNTAIN


RED


SPRINGS

PROJ. MGR.:

SHEET OVERALL LANDSCAPE PLAN

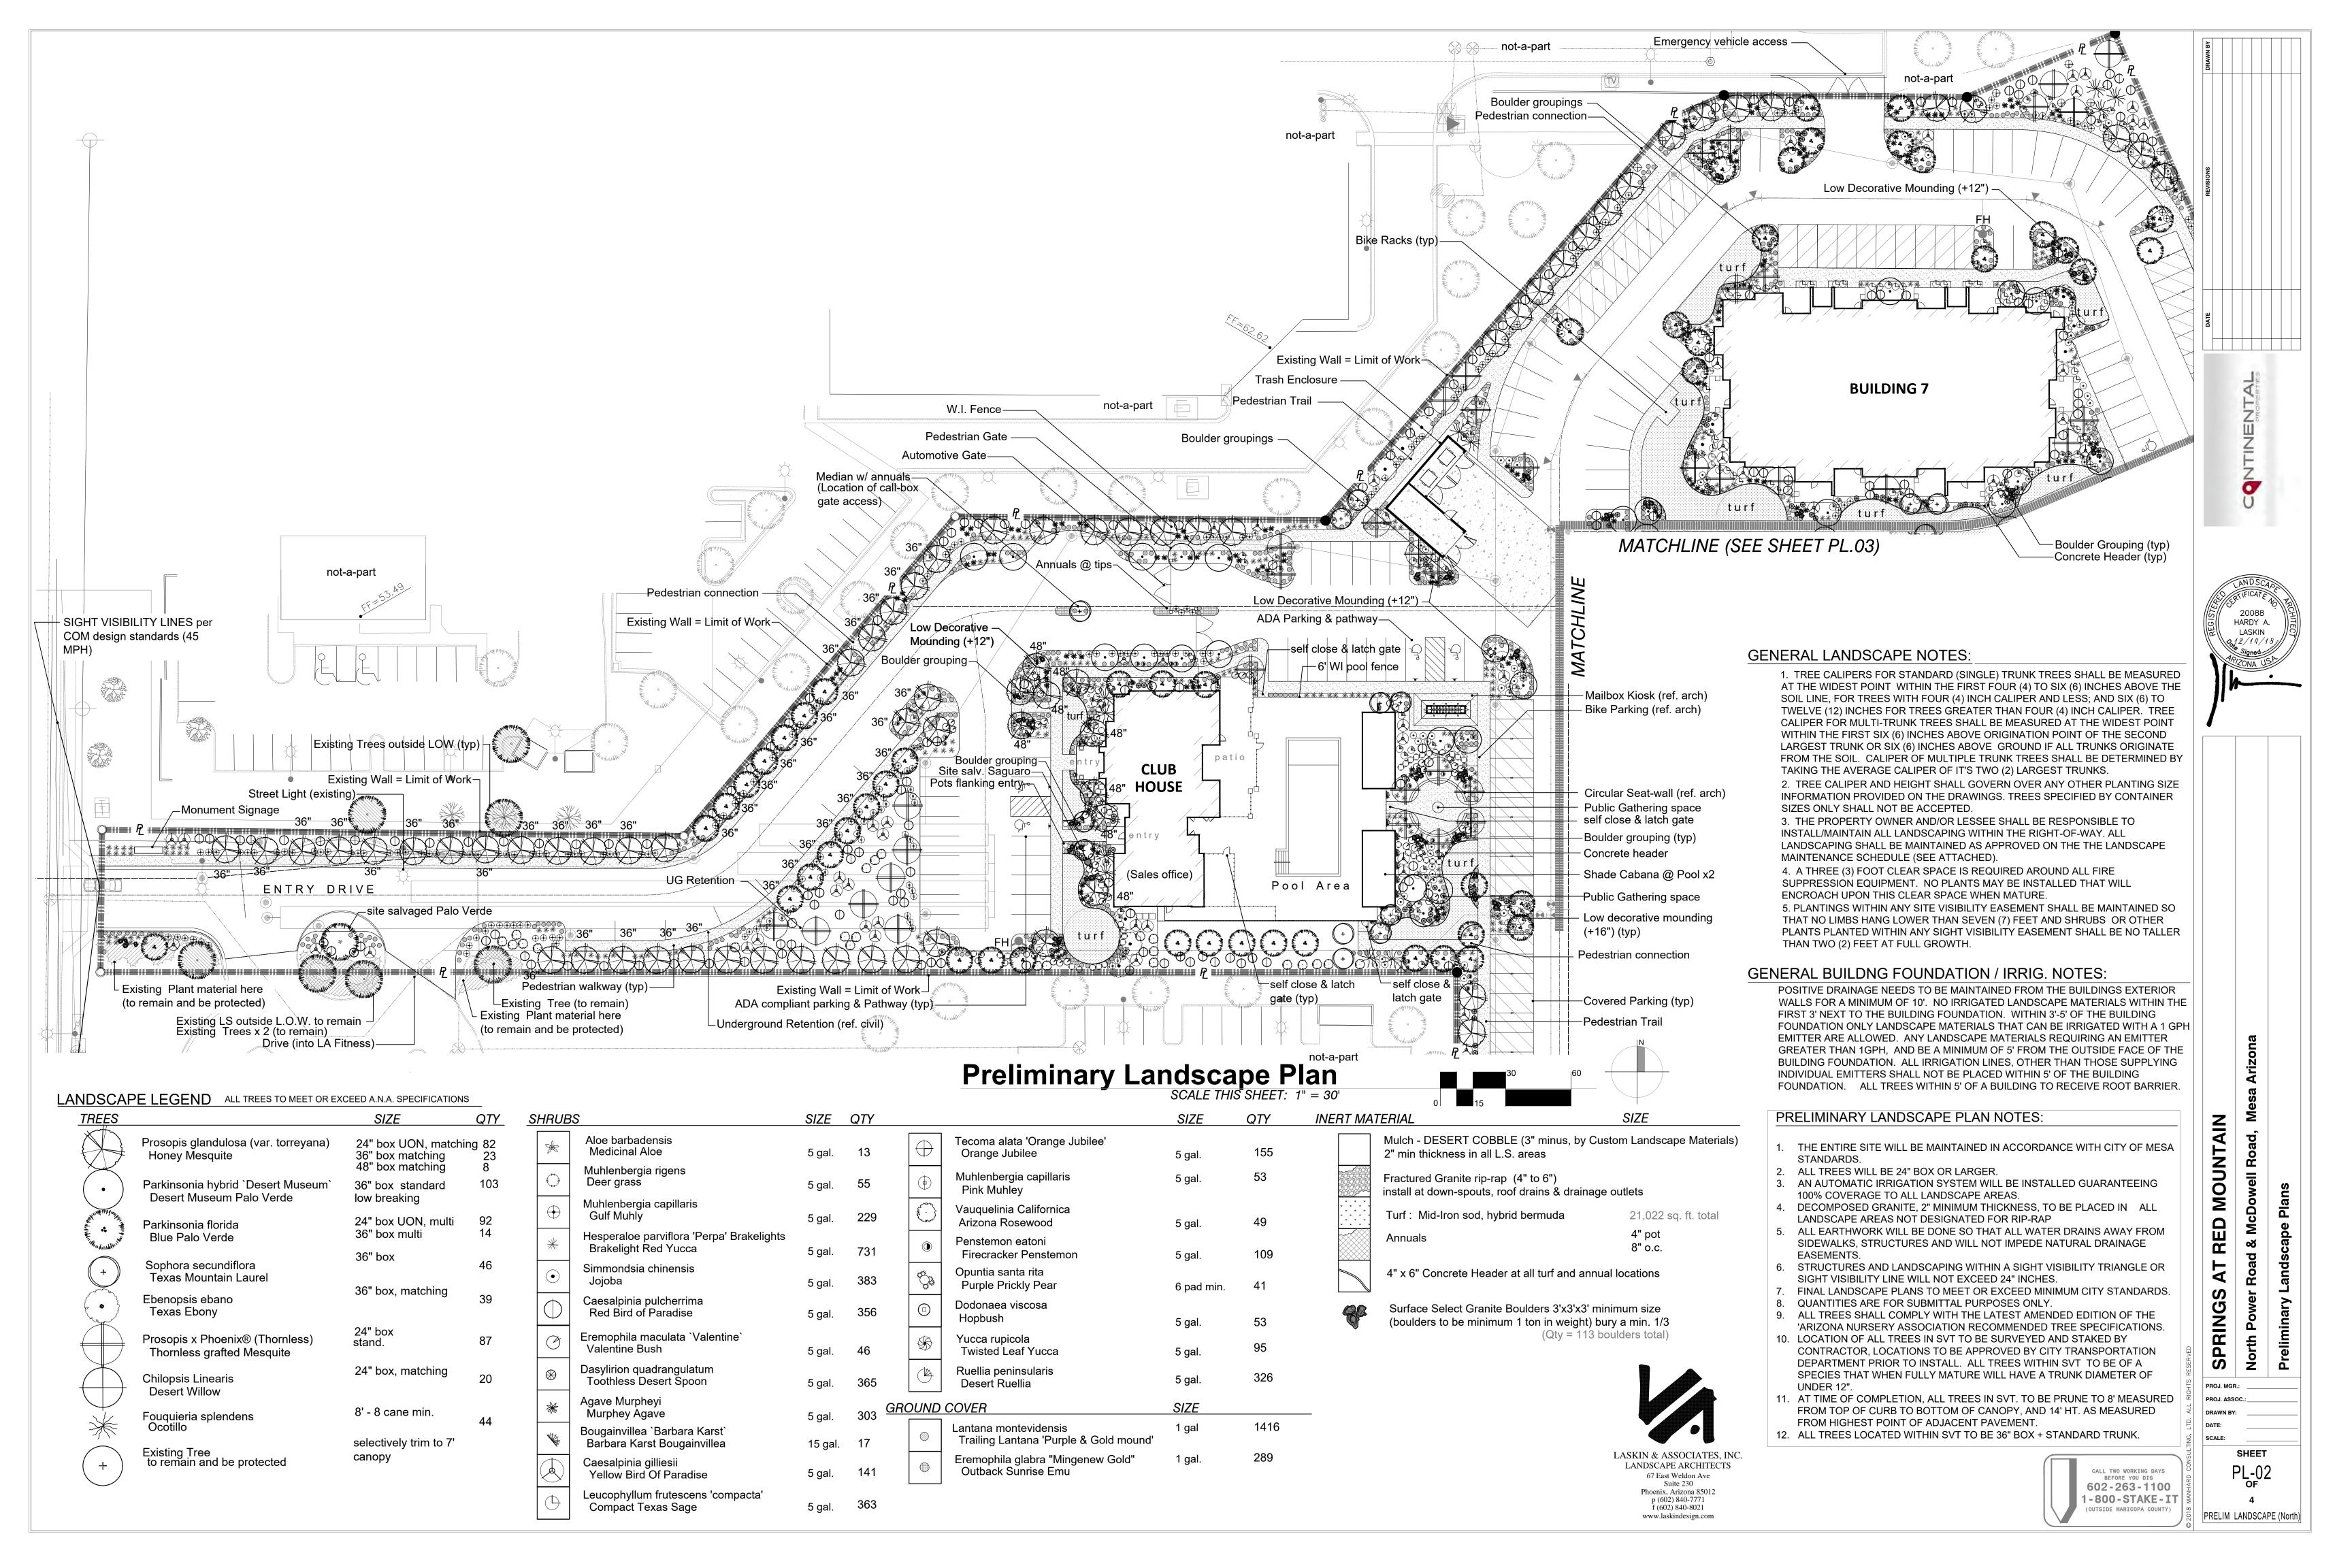

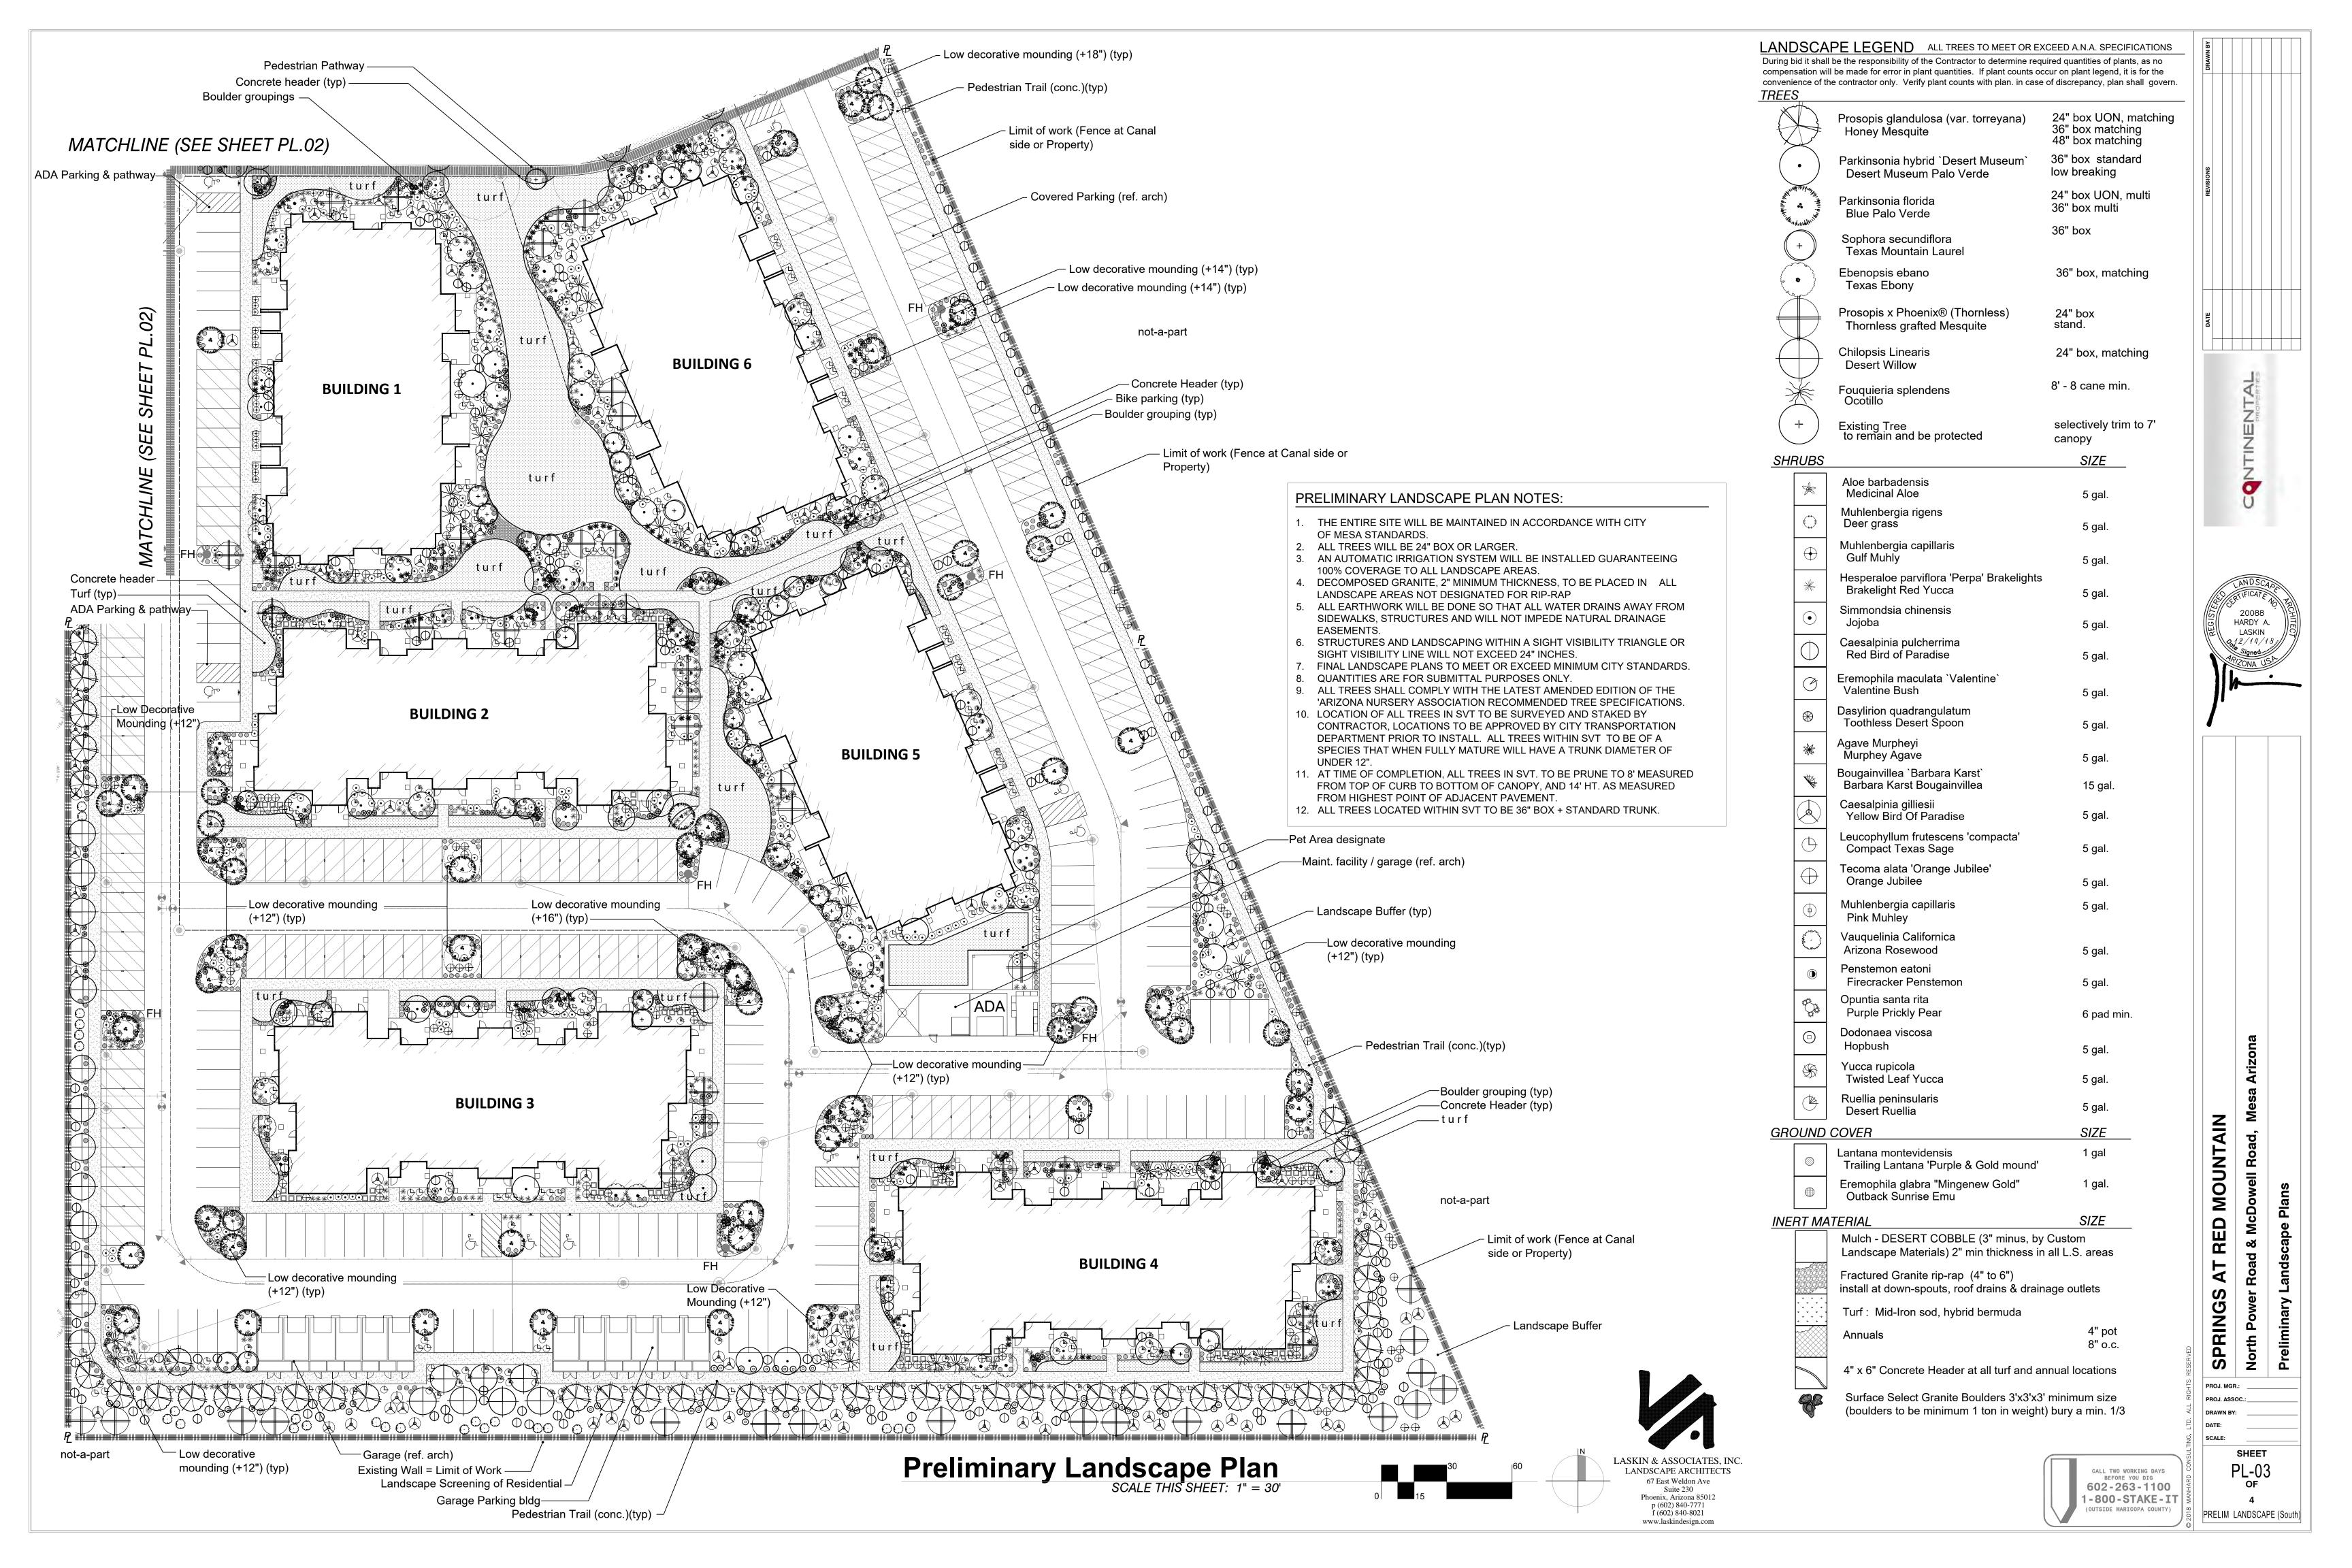

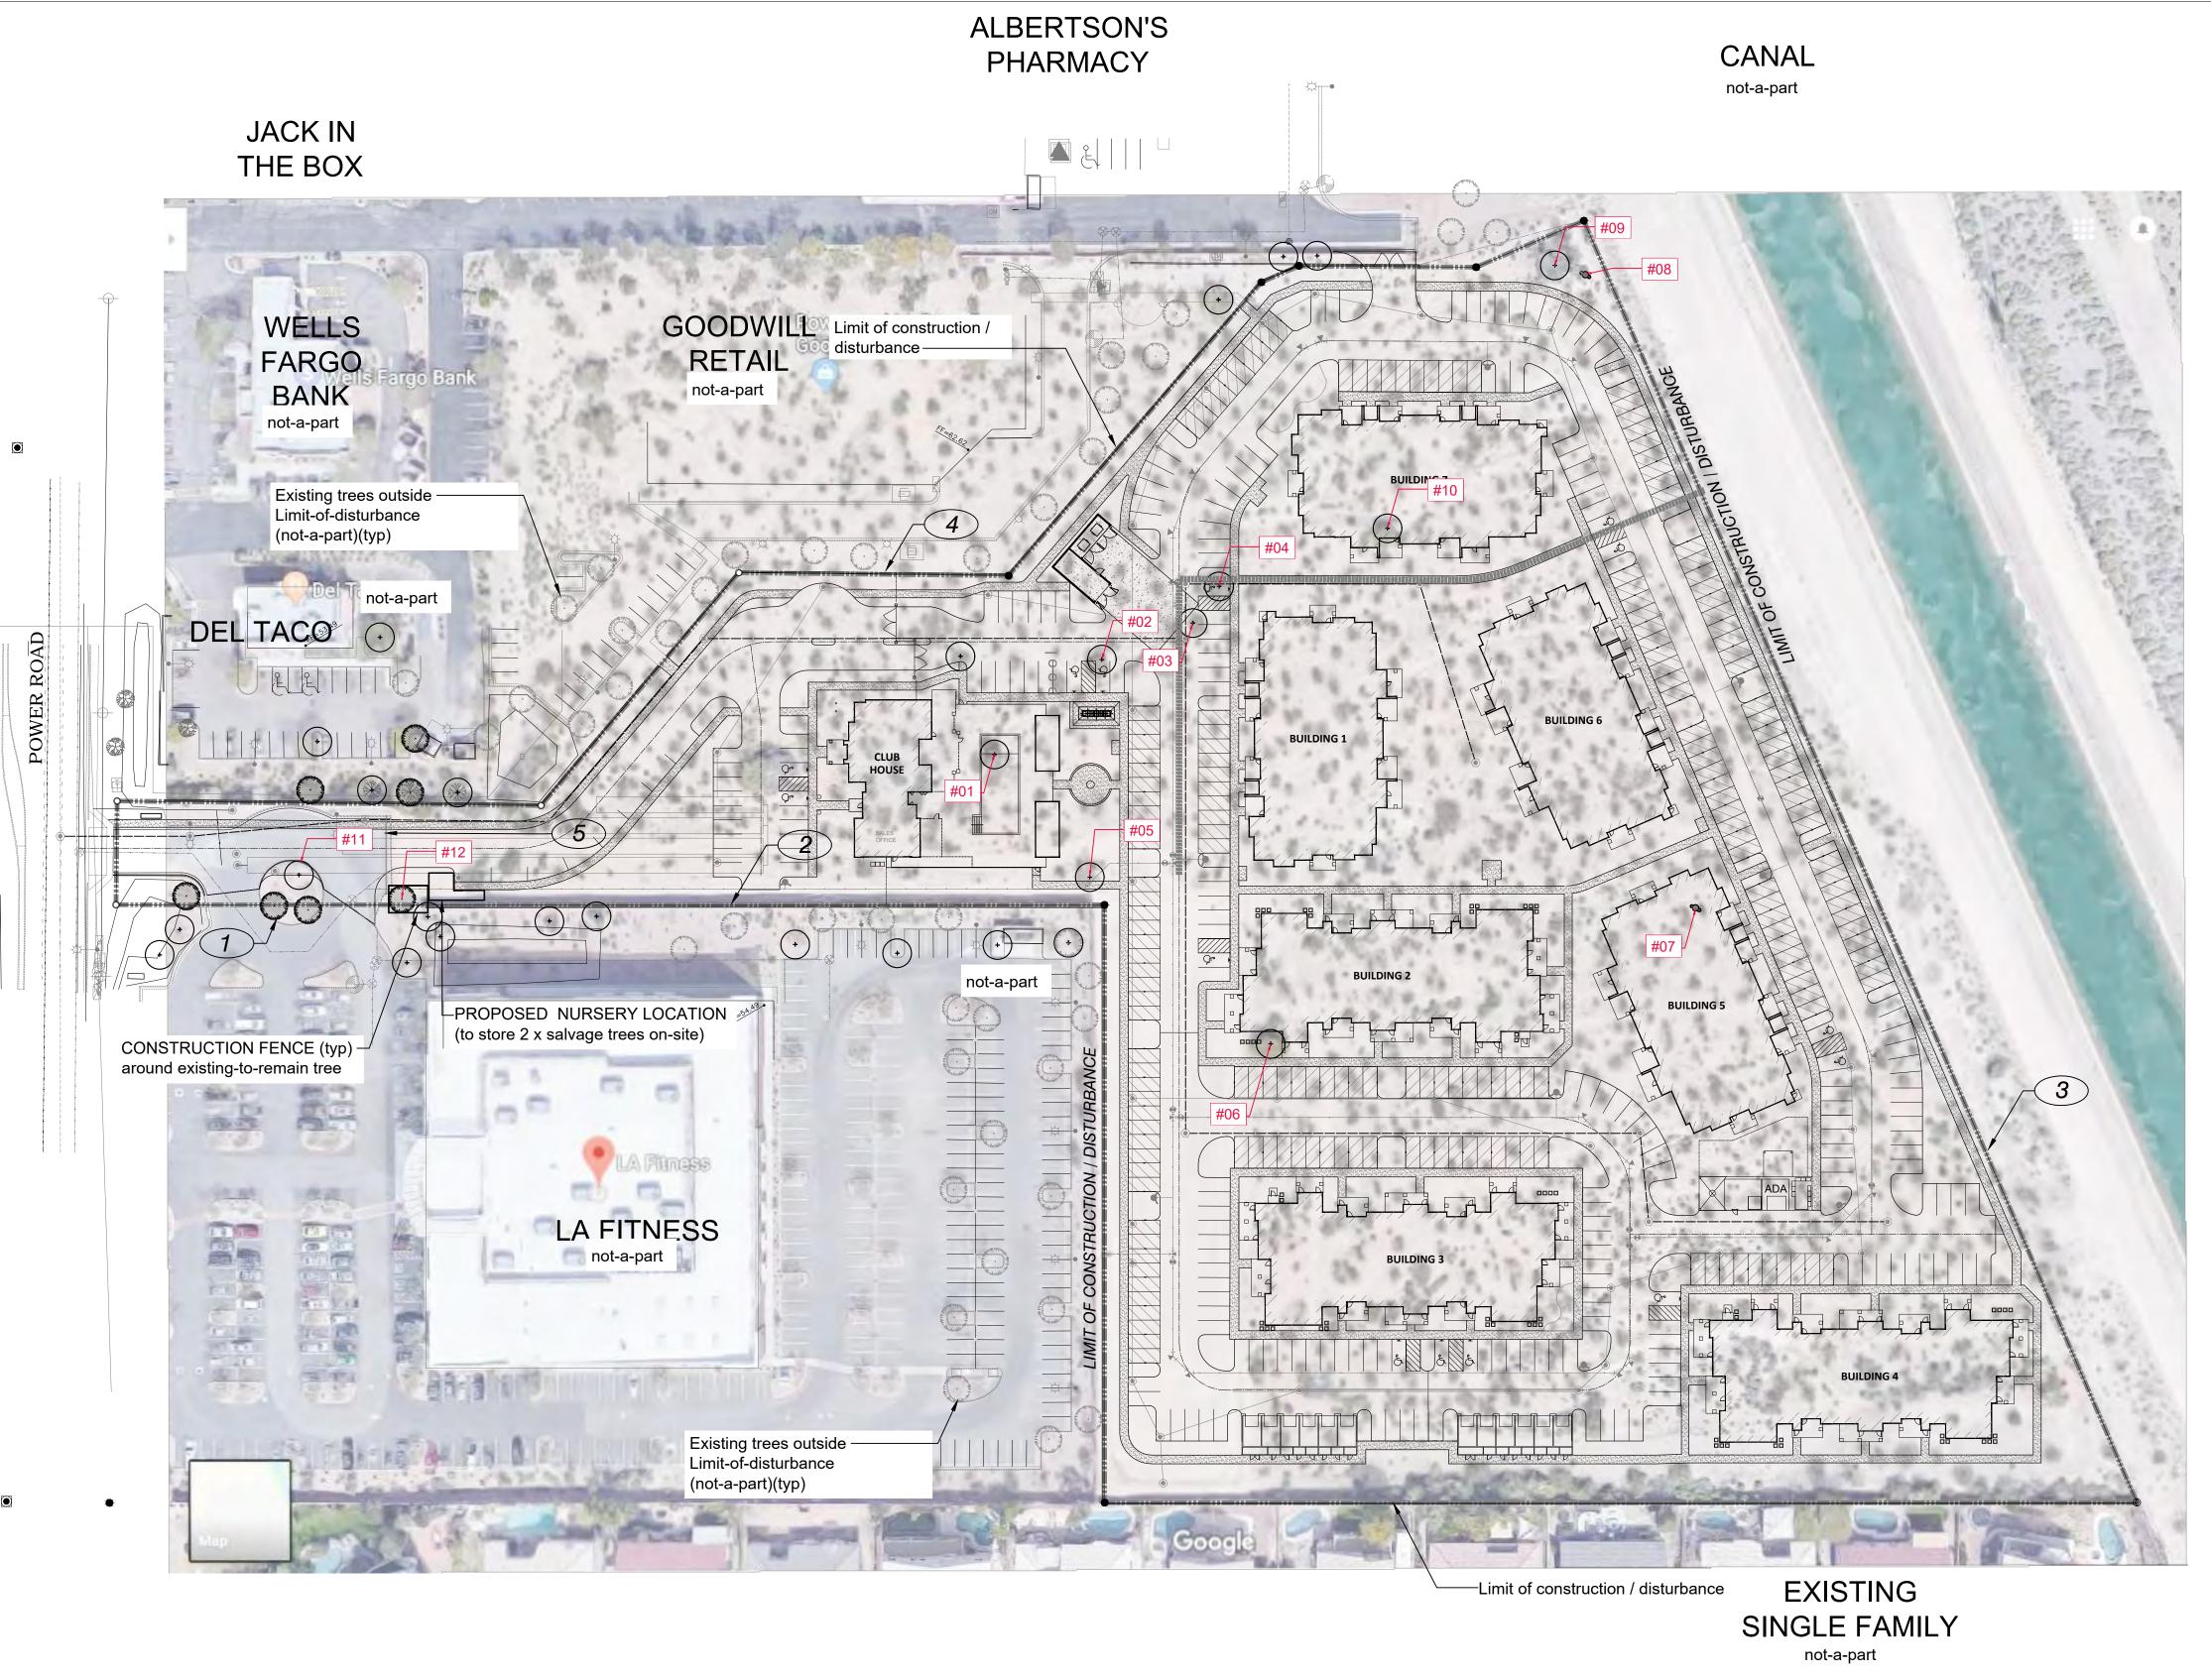

CULVER ST.

NATIVE PLANT PRESERVATION PLAN

Springs at Red Mountain
N. Power Rd. & McDowell Rd. Mesa AZ

** Existing Trees to remain shall be selectively but comprehensively pruned after installation of NEW Landscape material. Existing trees will be maintained so that no limbs hang lower than seven (7) feet.

Color Code as follows:

Red = Salvage and relocate

White = Preserve and protect in place

Blue = Destroy, not salvageable, cannot remain in place



NATIVE PLANT PRESERVATION PLAN

PROJECT INFO--

Gross Site Area 454,380 sf. 10.5 AC.

Total Proposed On-Site Landscape Area AC. (..... S.F.)

Proposed Use Multi-Family

Existing Tree *Within the L.O.W. line
to remain and be protected see plan for number and if damaged replace with a 36" box location and designation

#

SALVAGE TREE (refer to Native Plant Data, this sheet)

SALVAGE SAGUARO (refer to Native Plant Data, this sheet)

SITE FEATURES--

EXISTING DRIVE AND MEDIAN INCLUDING EXISTING

LANDSCAPE, AND IRRIGATION.

CMU WALL SEPARATING ADJACENT LA FITNESS PROPERTY

CHAIN LINK FENCE SEPARATING ADJACENT CAP WATER CANAL

SMU WALL SEPARATING ADJACENT GOODWILL AND DEL TACO PROPERTY

EXISTING CURB AND END-OF-DRIVE (START OF UNDISTURBED DESERT AREA)

INVENTORY OF NATURAL FEATURES-

THERE ARE NO SIGNIFICANT NATURAL FEATURES WITHIN OUR PROJECT SCOPE OTHER THAN TWO SAGUARO CACTI, ONE OF WHICH CAN BE SALVAGED, AND ONE THAT HAS FAR TOO MUCH DAMAGE TO ITS LOWER 1/3RD INCLUDING DEEP PERFORATION / ROT.

NATIVE PLANTS:

SPARSELY SCATTERED NATIVE PLANTS. RELATIVELY FLAT.

Debris includes concrete, also refer to Civil Plans for grading & drainage.

ONE SALVAGEABLE NATIVE SAGUARO (to be salvaged and relocated on-site)

NON-NATIVE PLANTS:

SEVERAL NATIVE AND NON-NATIVE EXISTING TREES OUTSIDE LIMIT-OF-WORK (owned by others, outside the limit of work line, on their own irrigation system and not a part of this project) To remain and be protected.

CANAL not-a-part

FIELD TAG COLORS:

RED = SALVAGE AND RELOCATE

VHITE = PRESERVE AND PROTECT IN PLACE

BLUE = DESTROY, NOT SALVAGEABLE, CANNOT REMAIN IN PLACE

COLORED TAGS IN FIELD ATTACHED ON PREDOMENENT SOUTH SIDE OF TREE, WITH NUMBER ON END OF TAG

NATIVE PLANT DATA (combo Salvage / Inventory plan)

S = Salvage, NS = Nonsalvagable, RIP = Remain In Place, D = Destroy, T = Transplant								
Plant #	Species	Common Name	Cal. (in)	Width (ft)	Height (ft)	Inventory Desig. S / NS	Intended Desig. RIP/ D/T	Comments
01	Parkinsonia	palo verde	8"	11'	17'	S	Т	transplant (selective pruning)
02	Parkinsonia	palo verde	9"	16'	21'	NS	D	bad form, unable dig all 4 sides
03	Parkinsonia	palo verde	9"	16'	20'	NS	D	unable dig all 4 sides
04	Prosopis	mesquite	8"	16'	16'	NS	D	dying, unable dig all 4 sides
05	Prosopis	mesquite	9"	18'	15'	NS	D	unable dig all 4 sides
06	Parkinsonia	palo verde	9"	18'	14'	NS	D	bad form, unable dig all 4 sides
07	Carnegiea gigantea	Saguaro	16"		18'	S	Т	bottom 1/3rd destroyed, holes
08	Carnegiea gigantea	Saguaro	12"		16'	NS	D	Relocate;maintain orientation to N
09	Prosopis	mesquite	8"	16'	17'	S	D	unable dig all 4 sides
10	Parkinsonia	palo verde	8"	13'	10'	S	RIP	Pruning required & create canopy
11	Parkinsonia	palo verde	7"	16'	20'	NS	D	unable dig all 4 sides
12	Parkinsonia	palo verde	9"	12'	16'	S	RIP	Pruning required & create canopy




LASKIN & ASSOCIATES, INC. LANDSCAPE ARCHITECTS 67 East Weldon Ave Suite 230 Phoenix, Arizona 85012 p (602) 840-7771 f (602) 840-8021 CALL TWO WORKING DAYS
BEFORE YOU DIG
602-263-1100
1-800-STAKE-IT
(OUTSIDE MARICOPA COUNTY)

PL-04
OF
4
Native Plant Preservation Plan

PRELIMINARY ENGINEERING FOR SPRINGS AT RED MOUNTAIN

A PORTION OF THE NORTHWEST QUARTER OF SECTION 6, TOWNSHIP 1 NORTH,
RANGE 7 EAST OF THE GILA AND SALT RIVER BASE AND MERIDIAN, MARICOPA COUNTY, ARIZONA

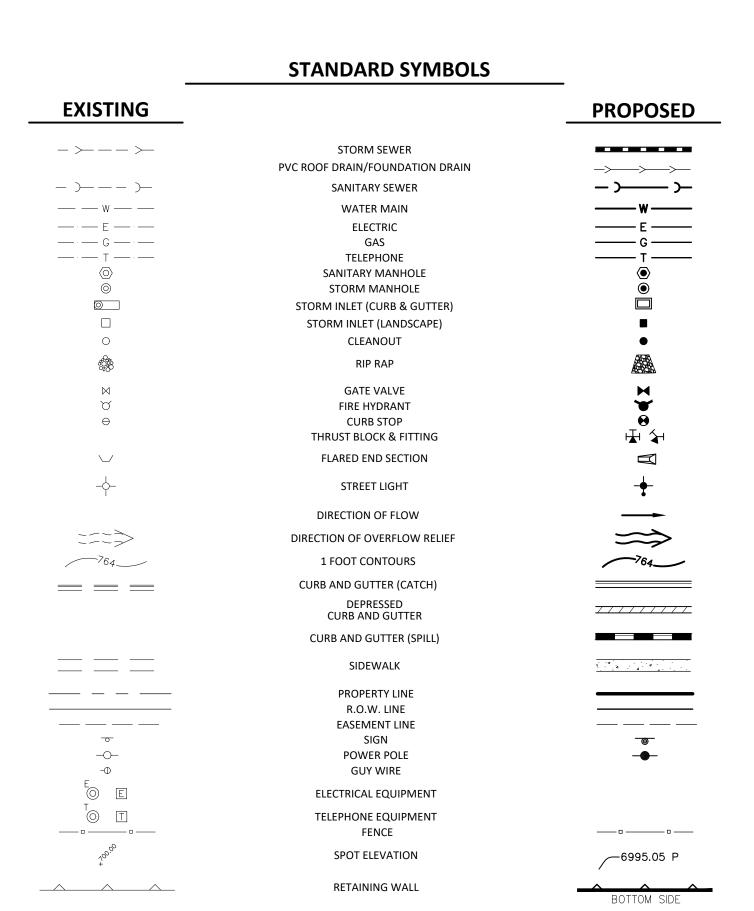

ABBREVIATIONS:

HYD

MAX

MH

MIN

PVI

INL

HIGH WATER LEVEL

HYDRANT

LOW POINT

MAXIMUM

MINIMUM

PAVEMENT

STORM MANHOLE

POINT OF CURVE

PROPERTY LINE

POINT OF TANGENCY

RCP REINFORCED CONCRETE PIPE

POWER POLE

PROP PROPOSED

RADIUS

REM REMOVAL

OFFSET FROM CENTERLINE

POINT OF INTERSECTION

POLYVINYL CHLORIDE PIPE

POINT OF VERTICAL CURVATURE

POINT OF VERTICAL TANGENCY

POINT OF VERTICAL INTERSECTION

POINT OF COMPOUND CURVE

INLET

INVERT

LEFT

ROW

RR

SHT

STA

STD

SW

TW

TYP

VΒ

 $\vee\vee$

WM

RIGHT-OF-WAY

SANITARY SEWER

SQUARE FOOT

STORM SEWER

SQUARE YARDS

THRUST BLOCK

TO BE REMOVED

TOP OF FOUNDATION

WSE WATER SURFACE ELEVATION

TOP OF CURB TEMPORARY

TOP OF PIPE

TOP OF WALL

VALVE BOX

VALVE VAULT

WATER MAIN

TRANS TRANSFORMER

TYPICAL

RAILROAD

RIGHT


SHEET

STATION

STANDARD

SIDEWALK

TELEPHONE

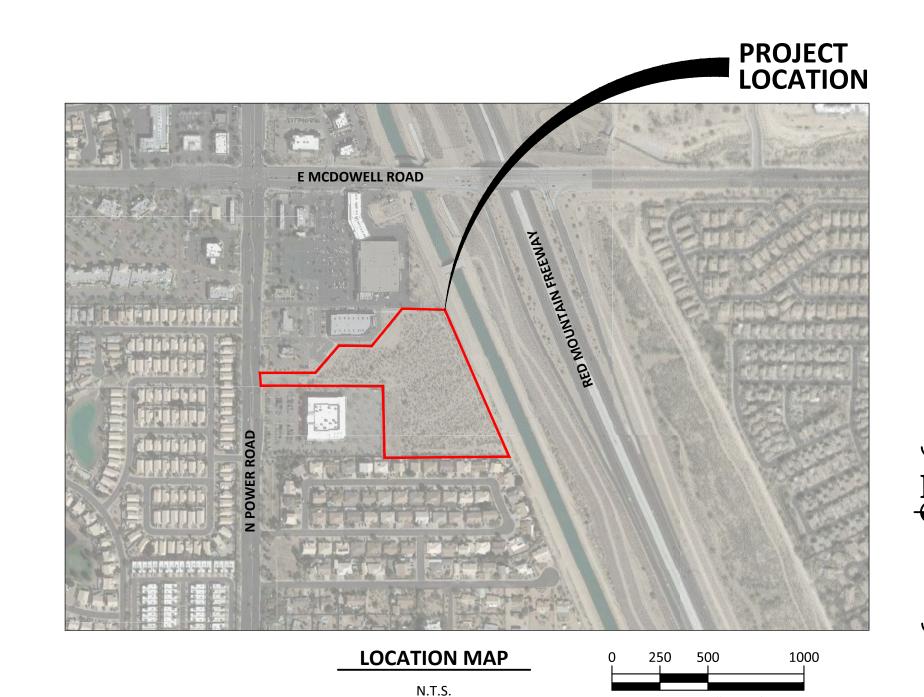



Manhard LTD

8008 E. Arapahoe Court, Suite 110, Centennial, CO 80112 ph:303.708.0500 fx:303.708.0400 manhard.com Civil Engineers • Surveyors • Water Resource Engineers • Water & Wastewater Engineers Construction Managers • Environmental Scientists • Landscape Architects • Planners

NOTES:

- 1. THE BOUNDARY LINES AND TOPOGRAPHY FOR THIS PROJECT ARE BASED ON A SURVEY PREPARED BY SURVEY INNOVATION GROUP, INC. DATED SEPTEMBER 11TH, 2018. THE CONTRACTOR SHALL VERIFY THE EXISTING CONDITIONS PRIOR TO CONSTRUCTION AND SHALL IMMEDIATELY NOTIFY MANHARD CONSULTING AND THE CLIENT IN WRITING OF ANY DIFFERING CONDITIONS. MANHARD CONSULTING HAS NOT VERIFIED THIS SURVEY AND IS NOT RESPONSIBLE FOR THE ACCURACY OF THE SURVEY BOUNDARY AND/OR TOPOGRAPHY.
- 1. MANHARD CONSULTING, LTD. IS NOT RESPONSIBLE FOR THE SAFETY OF ANY PARTY AT OR ON THE CONSTRUCTION SITE. SAFETY IS THE SOLE RESPONSIBILITY OF THE CONTRACTOR AND ANY OTHER PERSON OR ENTITY PERFORMING WORK OR SERVICES. NEITHER THE OWNER NOR ENGINEER ASSUMES ANY RESPONSIBILITY FOR THE JOB SITE SAFETY OF PERSONS ENGAGED IN THE WORK OR THE MEANS OR METHODS OF CONSTRUCTION.

BENCHMARKS:

URCE BENCHMARK:

FOUND BRASS TAG ON TOP OF CURB AT THE SOUTHWEST CORNER OF POWER ROAD AND MCDOWELL ROAD.

CITY OF MESA DATA NAVD88 DATUM ELEVATION = 1552.83'

SCALE: 1"=500'

BASIS OF BEARING

THE WEST LINE OF THE NORTHWEST QUARTER OF SECTION 6, AS SHOWN IN BOOK 915, PAGE 28, MARICOPA COUNTY RECORDS. SAID LINE BEARS SOUTH 00 DEGREES 36 MINUTES 50 SECONDS WEST.

INDEX OF SHEETS

SHEET NO DESCRIPTION

- 1 TITLE SHEET
- PRELIMINARY SITE DIMENSIONAL AND PAVING PLAN
- 3 PRELIMINARY UTILITY PLAN
- PRELIMINARY GRADING PLAN
- 5 PRELIMINARY DETENTION CALCULATIONS
- FIRE TRUCK TURN EXHIBIT
- 7 FIRE HYDRANT COVERAGE EXHIBIT

SITE INFORMA	ATION	
PROPERTY	10.43	ACRES
ZONING		RM-3
SQUARE FOOTAGE BREAKDOWN:		
BUILDING COVERAGE	93,426	SE
PARKING COVERAGE	160,215	
SIDEWALK COVERAGE	66,525	
OPEN SPACE/LANDSCAPED AREA	134,165	
TOTAL:	454,331	
TOTAL UNIT COUNT:	192	UNITS
DENSITY:	18.41	UNITS/ACRE
MINIMUM BUILDING SEPARATION	30	FEET
BUILDING/LANDSCAPE SETBACKS:		
NORTH	35/10	FEET
SOUTH	30/10	FEET
EAST	15/8	FEET
WEST	30/20	FEET
BUILDING INFOR	RMATION	
RESIDENT BUILDINGS	QUANTITY	
G24 (24 DU/BUILDING)	3	BUILDINGS
Z30 (30 DU/BUILDING)	4	BUILDINGS
TOTAL	7	BUILDINGS
BUILDING HEIGHT		
G24	25.5	FEET
Z30	37.8	FEET
GENERAL UNIT MIX	UNITS	PERCENTAG
STUDIO	36	19%
1-BEDROOM	72	38%
2-BEDROOM	66	34%
3-BEDROOM	18	9%
TOTAL	192	100%
PARKING INFOR	RMATION	
PARKING	Q	UANTITY
CARPORTS	190	GARAGES
DETACHED GARAGES	12	GARAGES
ADA ACCESSIBLE DETACHED GARAGE	1	GARAGE
TOTAL COVERED PARKING	203	GARAGES
SURFACE PARKING	191	SPACES
ADA SURFACE PARKING	13	SPACES
TOTAL UNCOVERED PARKING	204	SPACES
TOTAL PARKING PROVIDED	407	SPACES
PARKING REQUIRED PER CODE	404	SPACES
UNIT PARKING RATIO	2.12	2011322
COVERED PARKING RATIO	1.06	
PARKING DIMENSIONS		
STANDARD STALL	9'x18'	
ADA STALL	9'x18'	
DADALLEL STALL	0'v23'	

9'x23'

24'

PARALLEL STALL

DRIVE AISLE WIDTH



ADJUST

BW

CONC

ELEV

FES

CY

AGGREGATE GRAVEL

BEGIN VERTICAL CURVE

CORRUGATED METAL PIPE

BACK OF CURB

BOTTOM OF PIPE

BACK OF WALK

CENTERLINE

CONCRETE

DIAMETER

ELEVATION

EXISTING

FLOW LINE

HIGH POINT

FORCE MAIN

GATE VALVE

CUBIC YARD

DUCTILE IRON PIPE

EDGE OF PAVEMENT


END VERTICAL CURVE

FLARED END SECTION

HIGH DENSITY POLYETHYLENE

FINISHED FLOOR

FINISHED GRADE

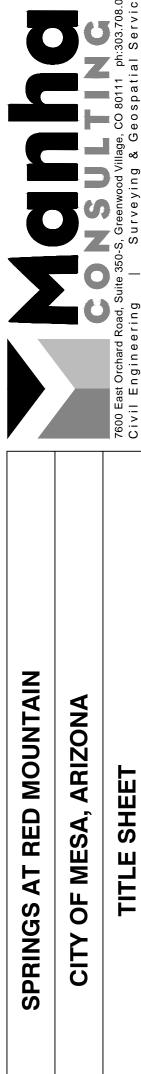

PROJ. MGR.: DJM

PROJ. ASSOC.: CAS

12-14-18

SHEET

DRAWN BY:

